




CA 4716 (PELS) EXPIRES 6/30/2017

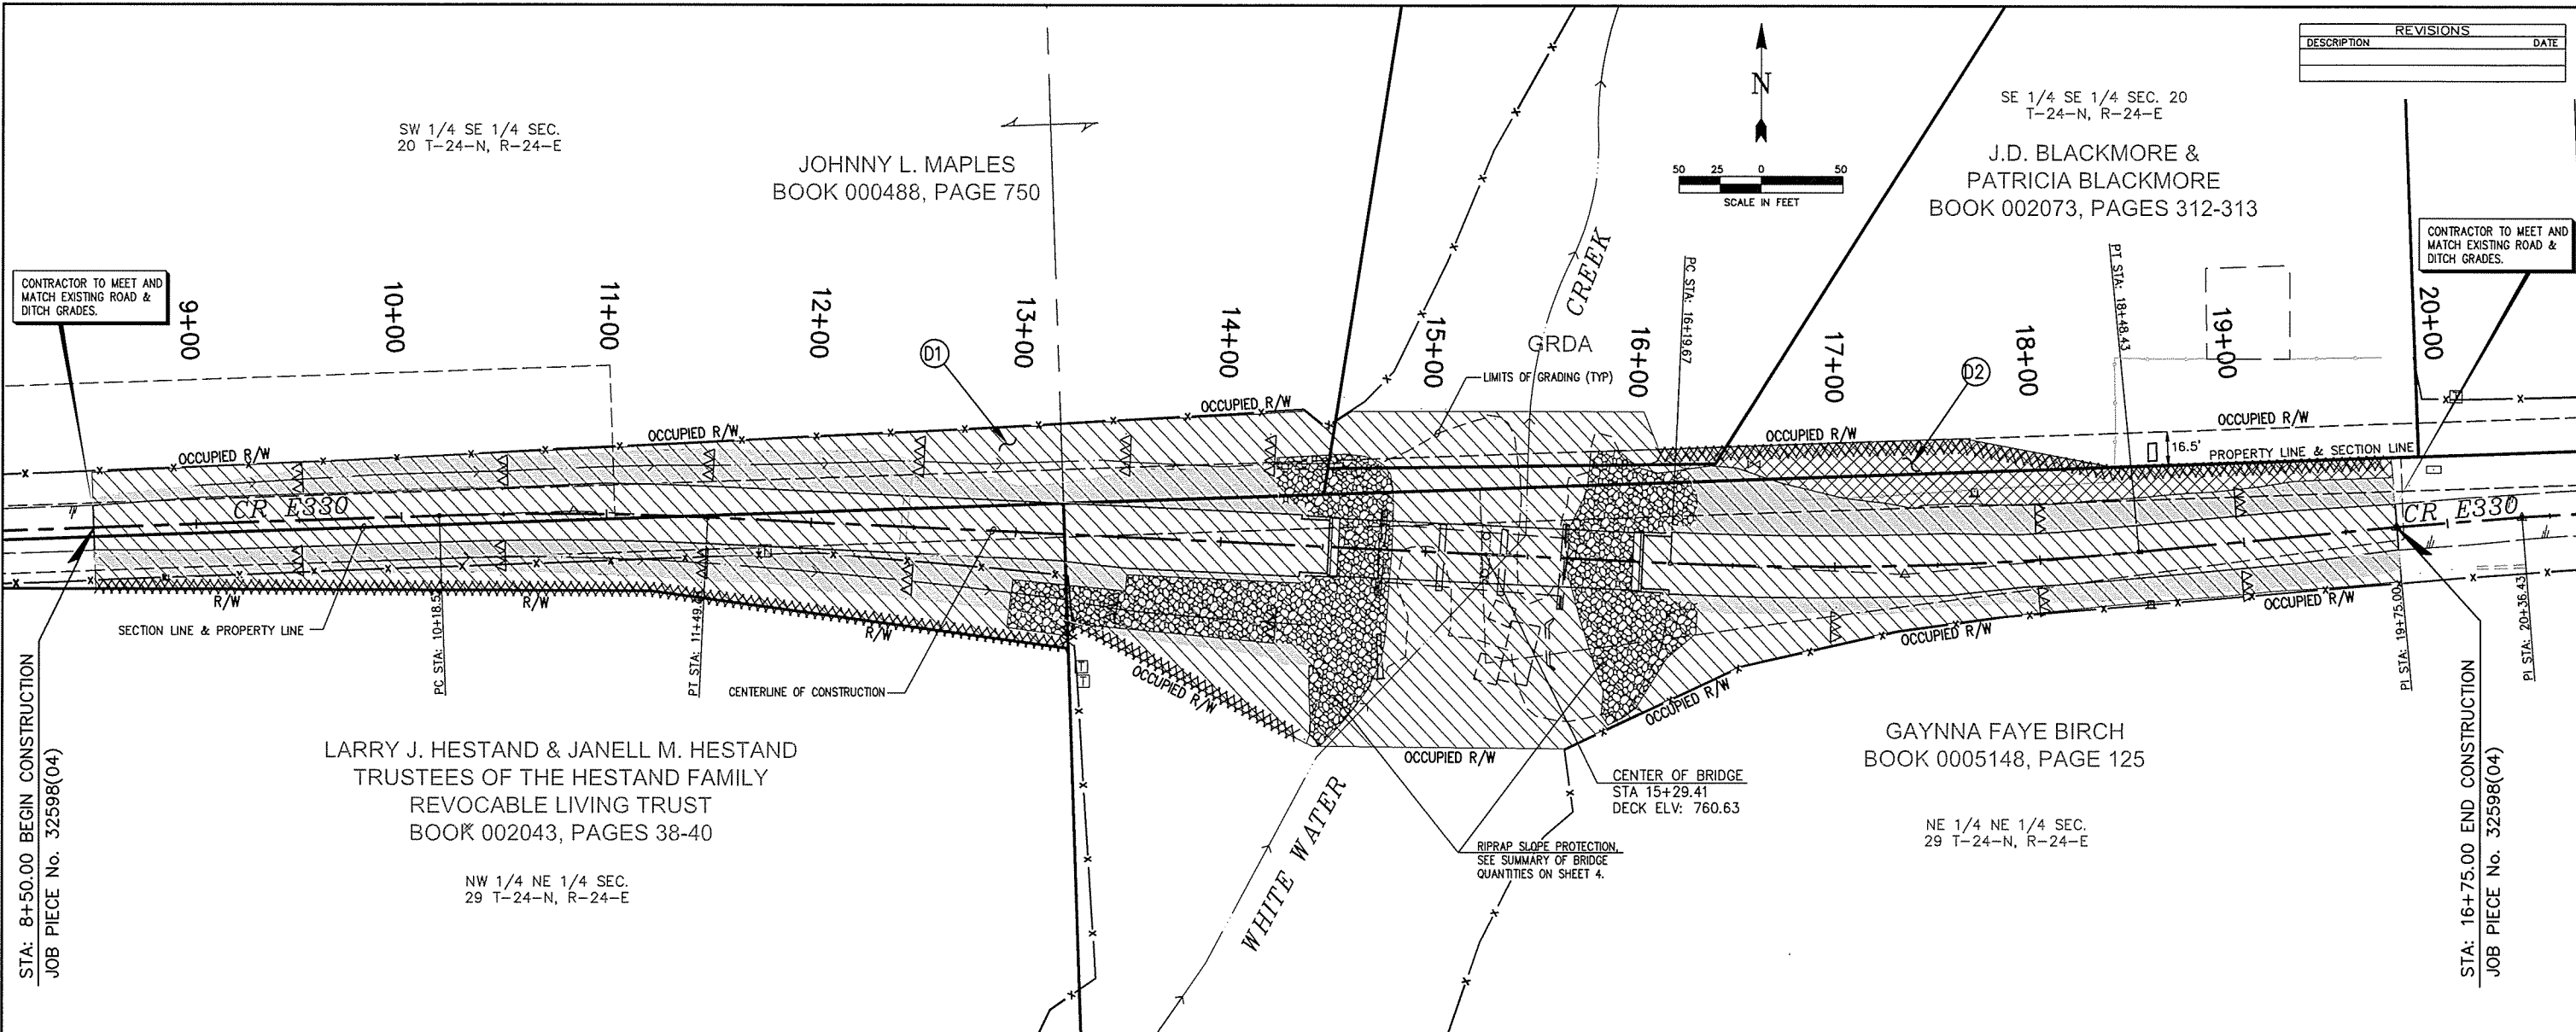

DESCRIPTION	REVISIONS	DATE

STA: 8+50.00 BEGIN CONSTRUCTION  
JOB PIECE No. 32598(04)

STA: 16+75.00 END CONSTRUCTION  
JOB PIECE No. 32598(04)

DRAINAGE AREA NUMBER	OUTFALL STATION	ACRES	
		CHANNEL FLOW AREA	SHEET FLOW AREA
D1	CRL STA 15+29.41	2.33	0.15
D2	N/A		
TOTAL		2.48	


LOCATION	DESCRIPTION	SILT DIKE 221(F)			SILT FENCE 221(C)	SOD 230(A)
		Occurrences	Lineal Feet Each	Total	Lineal Feet	S. Yards
8+50 to 14+45	X				615	
16+12 to 19+74	X				357	
9+50 and 11+50	X					
12+50 to 14+23	X	3	10	30		
9+50 to 14+26	X	3	20	60		
18+00 to 19+00	X	2	10	20		
17+00 to 19+00	X	2	20	40		
8+50 to 14+42	X					887
8+50 to 14+46	X					1,287
16+17 to 19+75	X					622
16+17 to 19+75	X					318
Totals		220	972	3,114		

Note, Lengths of SILT FENCE shown, are measured along the fence, not the C.R.L.

- LEGEND**
- RIGHT-OF-WAY
  - FLOWLINE OF DITCH
  - LIMITS OF GRADING
  - EXISTING FENCE
  - TEMPORARY SILT DIKE
  - TEMPORARY SILT FENCE
  - RIPRAP (PERMANENT EROSION CONTROL)
  - SOLID SLAB SOD (PERMANENT EROSION CONTROL)
  - AREA OF SHEET FLOW
  - AREA OF CHANNEL FLOW

SEE SHEET 3 FOR GENERAL NOTES

SEE SHEET 13 FOR STORM WATER MANAGEMENT PLAN

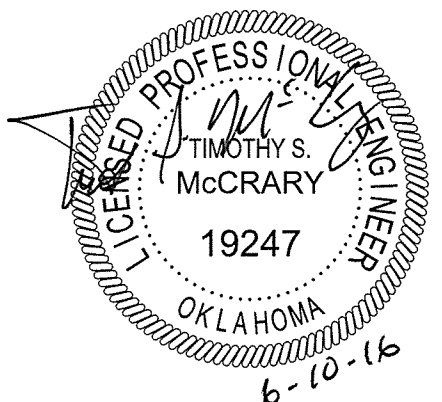

Design	GLB	4/16	DELAWARE COUNTY	WHITE WATER CREEK BRIDGE
Drawn	JDF	4/16	<b>EROSION CONTROL PLAN</b>	
Checked	TSM	6/16		
Approved				
Squad			County: DELAWARE	Project No. J/P 32598(04) Sheet No. 12

Time: 5:32 pm  
Scale: 1"=50' (PC)  
Date: 6/2/2016  
© 2016 by Rose & McCrary, P.C.  
Drawing Name: 16046-001.ENG.DWG\16046-00 Erosion Control.dwg (jrancis)  
Xrefs Used: SUR, OBEING, Isocad\IM, TB

ALL DIMENSIONS ARE IN FEET UNLESS OTHERWISE NOTED ON PLANS.